

FOODSERVICE EQUIPMENT FLOOR PLAN
1/4" = 1'-0"

EQUIPMENT SCHEDULE

ID#	QTY	DESCRIPTION	REMARKS
B1	1	UNDERBAR HAND SINK	-
B2	1	UNDERBAR COCKTAIL STATION W/COLD PLATE	-
B21	1	DOUBLE SPENDERAL	-
B22	1	SOVA BIN HODDER	-
B4	1	W/LO PROSITER - (MOBILE)	-
B41	1	SINGE SPENDERAL	-
B5	1	BACKBAR STORAGE CABINET	TWO DOORS
B6	1	BACKBAR STORAGE CABINET	TWO DOORS
B61	1	BEER SYSTEM	-
B62	1	BEER SYSTEM POWER PAK	-
B7	1	BEER TAPS (36) AND DRAIN PAK	-
B8	2	BEER SYSTEM POWER PAK	-
B81	1	BEER SYSTEM RACK SHELF	-
B82	1	BEER SYSTEM RACK SHELF	-
B83	1	BEER SYSTEM RACK SHELF	-
B84	1	BEER SYSTEM RACK SHELF	-
B85	1	BEER SYSTEM RACK SHELF	-
B86	1	BEER SYSTEM RACK SHELF	-
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B810	1	BEER SYSTEM RACK SHELF	-
B811	1	BEER SYSTEM RACK SHELF	-
B812	1	BEER SYSTEM RACK SHELF	-
B813	1	BEER SYSTEM RACK SHELF	-
B814	1	BEER SYSTEM RACK SHELF	-
B815	1	BEER SYSTEM RACK SHELF	-
B816	1	BEER SYSTEM RACK SHELF	-
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B818	1	BEER SYSTEM RACK SHELF	-
B819	1	BEER SYSTEM RACK SHELF	-
B820	1	BEER SYSTEM RACK SHELF	-
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B899	1	BEER SYSTEM RACK SHELF	-
B900	1	BEER SYSTEM RACK SHELF	-

BAR EQUIPMENT

B1	1	UNDERBAR HAND SINK	-
B2	1	UNDERBAR COCKTAIL STATION W/COLD PLATE	-
B21	1	DOUBLE SPENDERAL	-
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Strategic
EQUIPMENT AND SUPPLY CORPORATION

3011 Industrial Parkway East
Knoxville, Tennessee 37921
(Pleasant Ridge Industrial Park)
Phone (865) 637-2525
Fax (865) 522-4448

THIS DRAWING AND ALL INFORMATION HEREIN ARE STRATEGIC AND MAY NOT BE USED OR COPIED, EITHER IN WHOLE OR IN PART, WITHOUT THE WRITTEN CONSENT OF THE STRATEGIC

REVISIONS



NO.	DATE	DESCRIPTION
1	02-24-2012	MEP DRAWINGS
2	02-24-2012	HIGH CHANGES
3	02-24-2012	HIGH CHANGES
4	02-24-2012	CONCEPTUAL DESIGN
5	02-24-2012	CONCEPTUAL DESIGN

Mellow Mushroom Pizza Bakers
16000 Steubner Airline Road
Spring, TX 77379
FOODSERVICE EQUIPMENT FLOOR PLAN

SCALE	1/4" = 1'-0"
DRAWN BY	JM
CHECKED BY	BR
DATE DRAWN	01-12-2012
DATE ISSUED	
PROJECT NO.	1202-F-06

FS-1

SHEET NUMBER

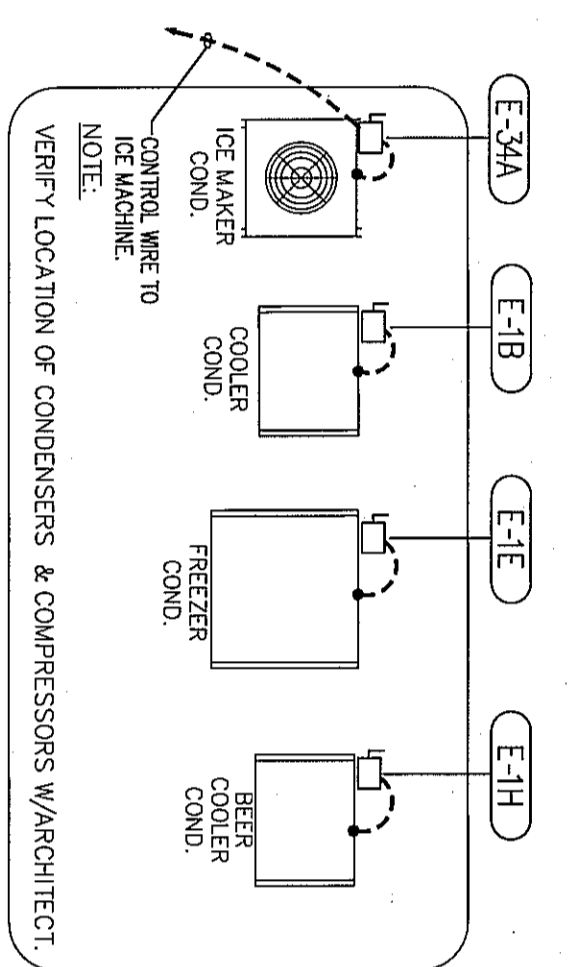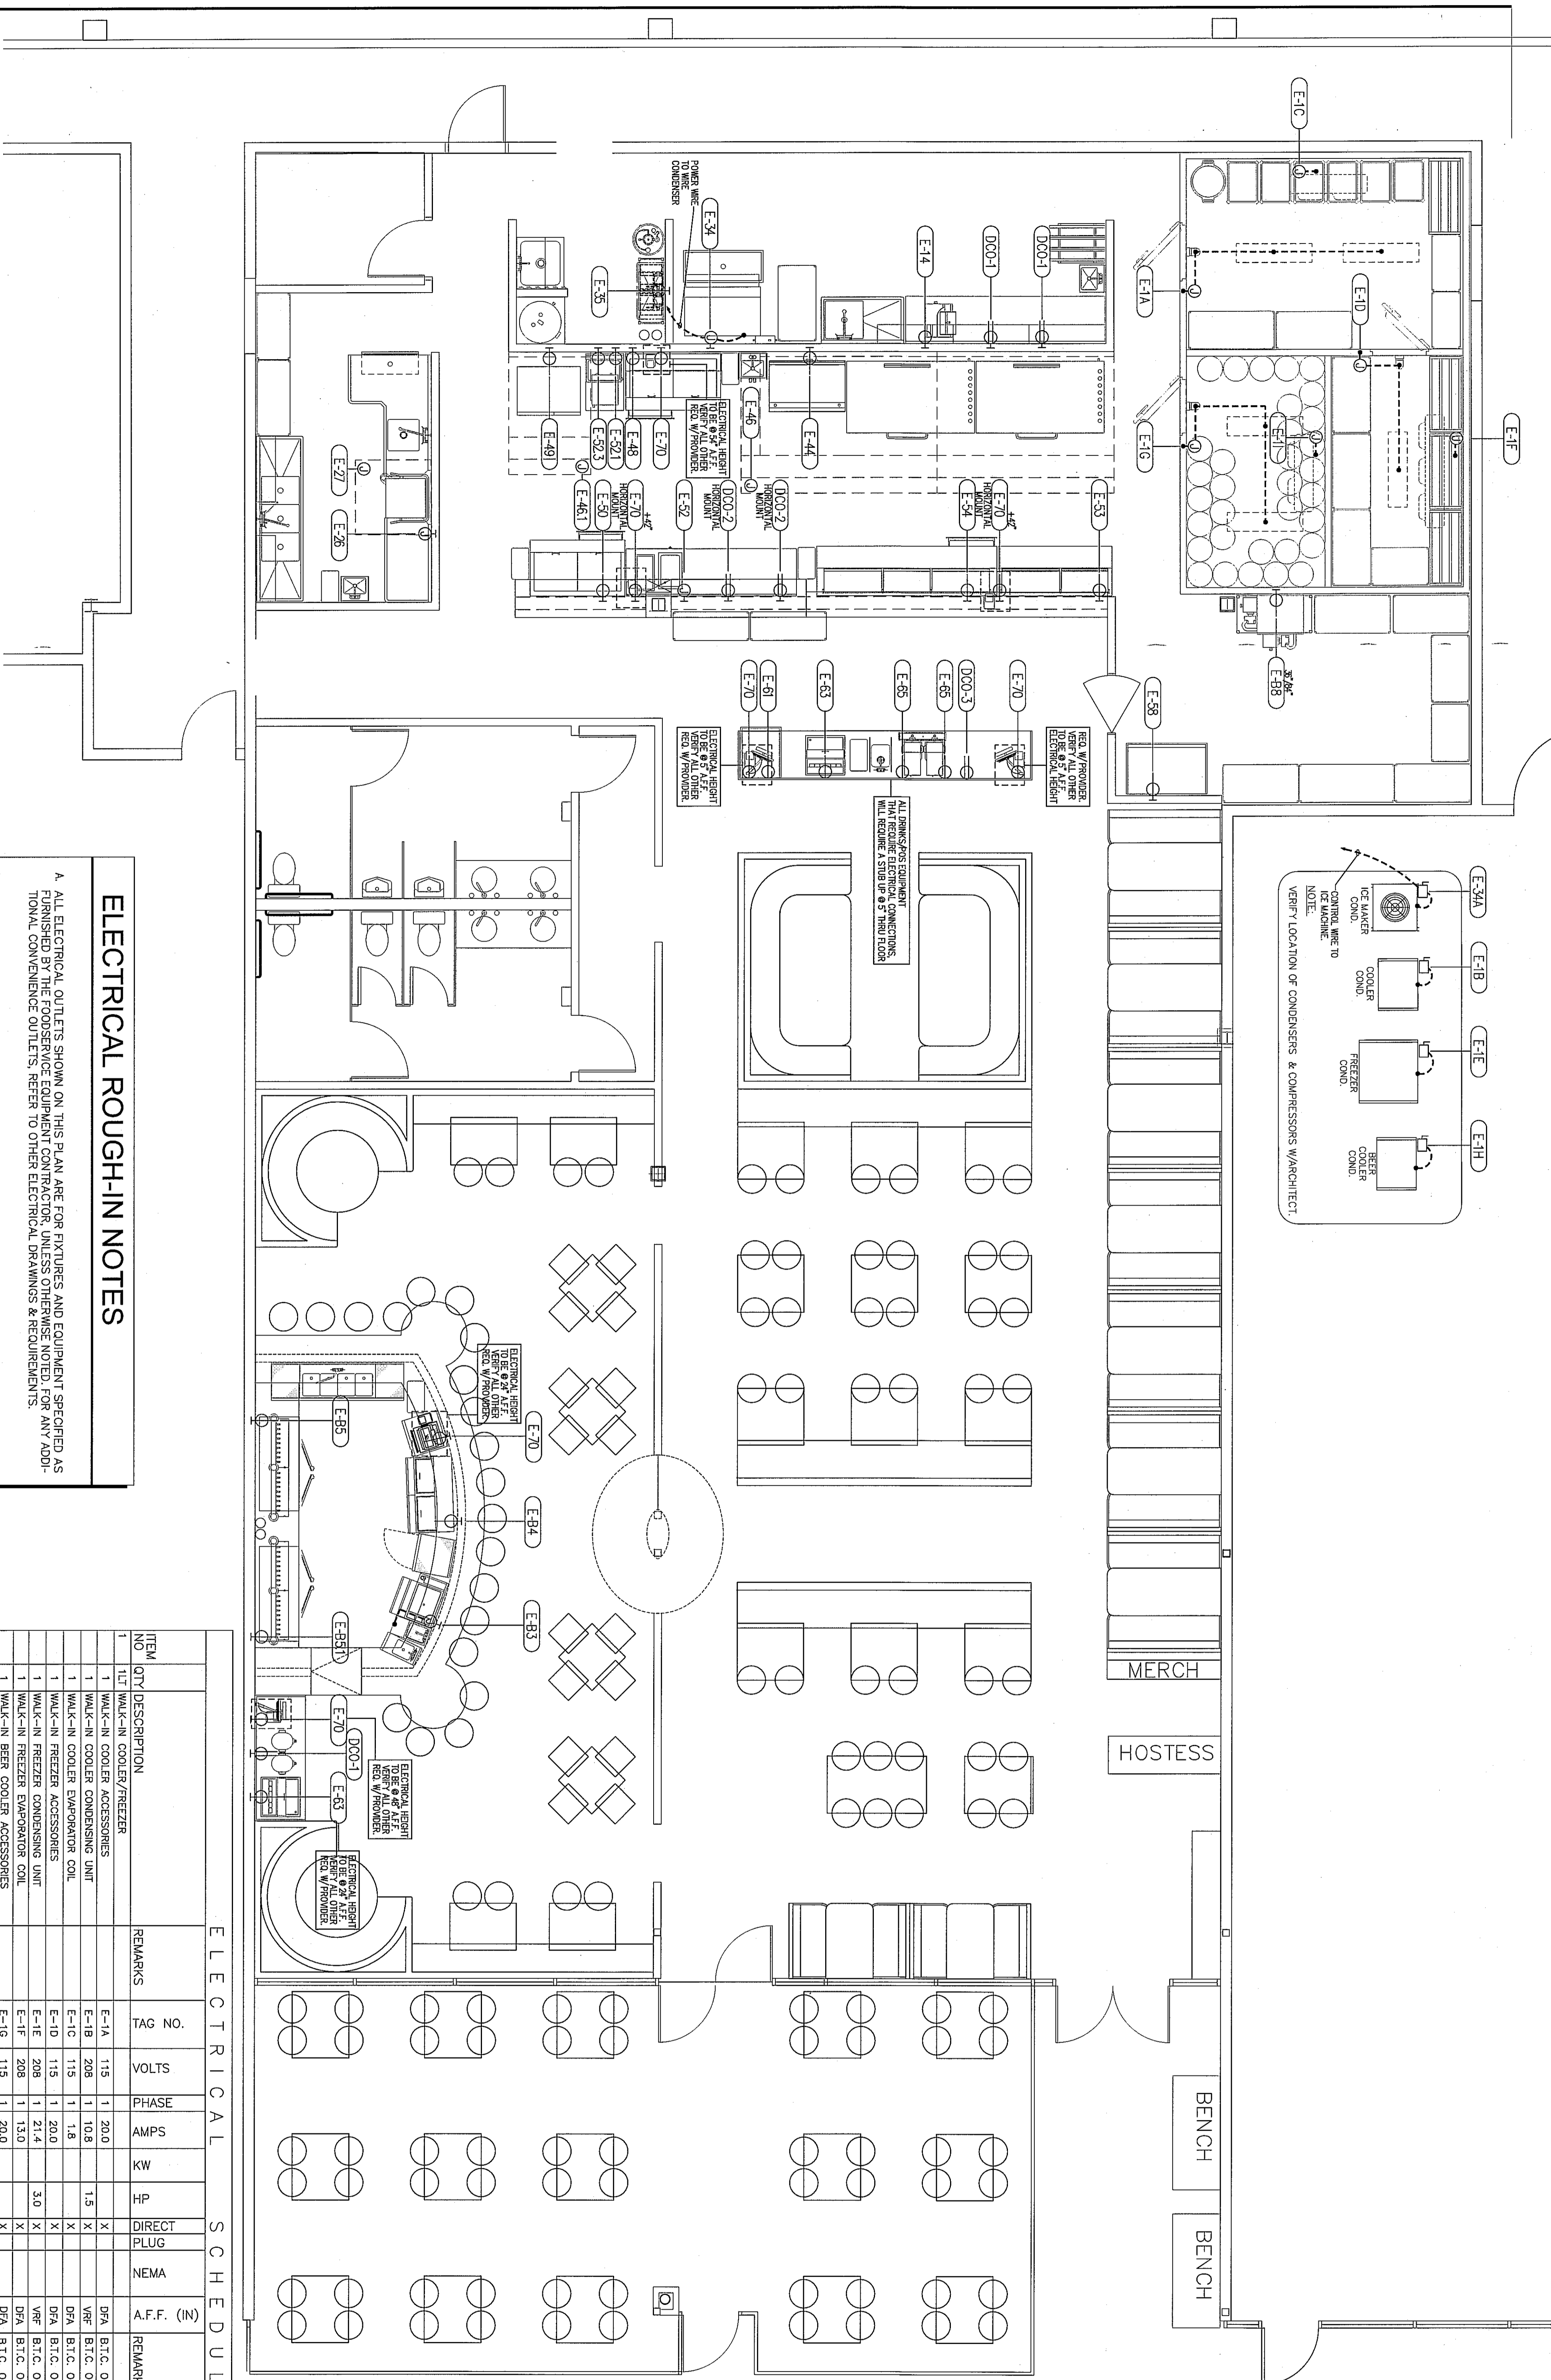

ELECTRICAL ROUGH-IN NOTES



- A. ALL ELECTRICAL OUTLETS SHOWN ON THIS PLAN ARE FOR FIXTURES AND EQUIPMENT SPECIFIED AS TURNKEY BY THE FOODSERVICE EQUIPMENT CONTRACTOR, UNLESS OTHERWISE NOTED. FOR ANY ADDITIONAL CONVENIENCE OUTLETS, REFER TO OTHER ELECTRICAL DRAWINGS AND REQUIREMENTS.
- B. ALL 120V OUTLETS NOT DESIGNATED WITH SPECIFIC LOADS TO BE RATED AT 15 AMPS WITH MINIMUM LOADING.
- C. ALL ROUGH-INS SHOWN ARE TO BE RUN INSIDE WALLS, (EXCEPT STUB-UPS), LOCATIONS INDICATE POINT OF EXIT FROM WALLS, CEILING OR FLOOR. (UNLESS NOTED OTHERWISE)
- D. ELECTRICAL CONTRACTOR TO BRANCH TO CONNECTION WHERE REQUIRED AND TO CONNECT ALL ELECTRICAL EQUIPMENT AND FIXTURES AND TO ANY INTERNAL WIRING REQUIRED IN THE FIXTURES INCLUDING INTER WIRING TO APPLIANCES AS REQUIRED BY THE SPECIFICATION AND/OR DRAWINGS.
- E. ALL ELECTRICAL OUTLET COVER PLATES ARE TO BE STAINLESS STEEL, THOSE REQUIRED IN BUILDING STRUCTURES ARE TO BE FINISHED BY THE ELECTRICAL CONTRACTOR. ALL MAIN BREAKER PANELS AND SUBPANELS ARE TO BE FINISHED BY THE ELECTRICAL CONTRACTOR AT TIME OF INSTALLATION.
- F. ELECTRICAL CONTRACTOR TO PROVIDE THE IN WIRING SYSTEMS PROTECTION (GFCI, AFCI, ETC.) REQUIREMENTS FOR EMERGENCY SHUTDOWN OF ENTIRE COOKLINE. SHUNT TRIP CIRCUITRY MAY BE REQUIRED, REFER OTHER ELECTRICAL PLANS.
- G. UNLESS OTHERWISE INDICATED THE ELECTRICAL LOADS SPECIFIED ARE THE CONNECTED LOADS, FLUSE OR CIRCUIT BREAKER SIZE TO BE DETERMINED ACCORDINGLY, BASED UPON APPLICABLE CODE REQUIREMENTS. OVERSIGHTS OR ERRORS IN THE SCHEDULE DO NOT RELIEVE ELECTRICAL CONTRACTOR FROM COMPLETE REVIEW OF ALL ELECTRICAL DRAWINGS AND REQUIREMENTS. ALL DISCREPANCIES ON LOADS TO BE IDENTIFIED AND SHOWN IN DRAWINGS WILL ASSURE CORRECTNESS OF THIS WORK.
- H. ELECTRICAL CONTRACTOR TO PROVIDE AND INSTALL ALL SWITCHES, STARTERS, DISCONNECTS, CORDS ETC. TO ALL EQUIPMENT AND TO ALL ELECTRICAL EQUIPMENT. ALL ELECTRICAL EQUIPMENT SHALL BE INSTALLED IN FULL ACCORDANCE WITH APPLICABLE CITY, COUNTY, LOCAL STATE & FEDERAL CODES AND ALL OTHER APPLICABLE REGULATORY REQUIREMENTS.
- I. ELECTRICAL CONTRACTOR TO PROVIDE AND INSTALL ALL ELECTRICAL COMPONENTS NECESSARY TO PROVIDE SERVICE TO LOCATIONS & EQUIPMENT AS SHOWN ON THIS SHEET (UNLESS NOTED OTHERWISE AND FITTINGS SUPPLIED AND/OR INSTALLED BY FOODSERVICE EQUIPMENT CONTRACTOR).
- J. ELECTRICAL CONTRACTOR TO PROVIDE AND INSTALL ALL CONVENIENCE OUTLET, SHOWN AND NOT SHOWN ON DRAWINGS FOR KITCHEN (VERIFY LOCATIONS AND HEIGHT WORKING).
- K. ELECTRICAL CONTRACTOR TO PROVIDE AND INSTALL LIGHT BULBS FOR HOODS AND WALK-INS.

ELECTRICAL SYMBOLS

	RECESSED DISCONNECT SWITCH		IG ISOLATED GROUND - FOR POS SYSTEM
	ROUGH-IN FROM WALL		WP WATERPROOF COVER AT RECEPTACLE
	DUPLEX RECEPTACLE MTD. ON DROP CORD FROM CEILING		Field Wiring, Concealed in Wall.
	DUPLEX RECEPT. 20-AMP 120-VOLT		Field Wiring, Concealed in Ceiling
	DUPLEX RECEPT. 20-AMP 120-VOLT		V VOLTAGE
	DUPLEX RECEPT. 20-AMP 120-VOLT		H.P. HOSTESS POWER
	DUPLEX RECEPT. 20-AMP 120-VOLT		K.W. KITCHEN POWER
	DUPLEX RECEPT. 20-AMP 120-VOLT		D.F.A. DOWN FROM ABOVE
	DUPLEX RECEPT. 20-AMP 120-VOLT		B.T.C. BRANCH TO CONNECTION
	DUPLEX RECEPT. 20-AMP 120-VOLT		A.F.F. ABOVE FINISHED FLOOR
	DUPLEX RECEPT. 20-AMP 120-VOLT		TAG NUMBER

ELECTRICAL SCHEDULE

ITEM NO.	QTY	DESCRIPTION	REMARKS	TAG NO.	VOLTS	PHASE	AMPS	KW	HP	DIRECT PLUG	NEMA	(N) F.F.	REMARKS
1	1	WALK-IN COOLER/REFRIGERATOR		E-1A	115	1	20.0			X	5-15P	DVA	B.T.C. ON COOLER ACCESSORIES AS REQUIRED.
2	1	WALK-IN COOLER ACCESSORIES		E-1B	208	1	10.8			X	5-15P	DVA	B.T.C. ON COOLER ACCESSORIES AS REQUIRED.
3	1	WALK-IN COOLER CONDENSING UNIT		E-1C	115	1	1.8			X	5-15P	DVA	B.T.C. ON COOLER CONDENSING UNIT AS REQUIRED.
4	1	WALK-IN COOLER ACCESSORIES		E-1D	115	1	20.0			X	5-15P	DVA	B.T.C. ON COOLER ACCESSORIES AS REQUIRED.
5	1	WALK-IN FREEZER ACCESSORIES		E-1E	208	1	21.4			X	5-15P	DVA	B.T.C. ON FREEZER ACCESSORIES AS REQUIRED.
6	1	WALK-IN FREEZER CONDENSING UNIT		E-1F	208	1	3.0			X	5-15P	DVA	B.T.C. ON FREEZER CONDENSING UNIT AS REQUIRED.
7	1	WALK-IN FREEZER EVAPORATOR COIL		E-1G	208	1	1.3			X	5-15P	DVA	B.T.C. ON FREEZER EVAPORATOR COIL AS REQUIRED.
8	1	WALK-IN BEER COOLER ACCESSORIES		E-1H	115	1	20.0			X	5-15P	DVA	B.T.C. ON BEER COOLER ACCESSORIES AS REQUIRED.
9	1	WALK-IN BEER COOLER CONDENSING UNIT		E-1I	115	1	1.8			X	5-15P	DVA	B.T.C. ON BEER COOLER CONDENSING UNIT AS REQUIRED.
10	1	WALK-IN BEER COOLER EVAPORATOR COIL		E-1J	115	1	2.5			X	5-15P	DVA	B.T.C. ON BEER COOLER EVAPORATOR COIL AS REQUIRED.
11	1	WALK-IN BEER COOLER ACCESSORIES		E-1K	115	1	4.1			X	5-15P	DVA	B.T.C. ON BEER COOLER ACCESSORIES AS REQUIRED.
12	1	WALK-IN BEER COOLER CONDENSING UNIT		E-1L	208	1	2.4			X	5-15P	DVA	B.T.C. ON BEER COOLER CONDENSING UNIT AS REQUIRED.
13	1	WALK-IN BEER COOLER EVAPORATOR COIL		E-1M	208	1	4.8			X	5-15P	DVA	B.T.C. ON BEER COOLER EVAPORATOR COIL AS REQUIRED.
14	1	ICE MAKER, HIGH TEMP		E-2	115	1	1.4			X	5-15P	DVA	B.T.C. ON ICE MAKER, HIGH TEMP.
15	1	ICE MAKER W/RAIN & WATER FILTER		E-3	208	1	2.4			X	5-15P	DVA	B.T.C. ON ICE MAKER W/RAIN & WATER FILTER.
16	1	ICE MAKER CONDENSING UNIT		E-4	208	1	1.3			X	5-15P	DVA	B.T.C. ON ICE MAKER CONDENSING UNIT AS REQUIRED.
17	1	ICE MAKER EVAPORATOR COIL		E-5	208	1	1.3			X	5-15P	DVA	B.T.C. ON ICE MAKER EVAPORATOR COIL AS REQUIRED.
18	1	EXHAUST FAN		E-6	120	1	0.5			X	5-15P	DVA	B.T.C. ON EXHAUST FAN AS REQUIRED.
19	1	EXHAUST FAN, DOGGED		E-7	120	1	1.5			X	5-15P	DVA	B.T.C. ON EXHAUST FAN AS REQUIRED.
20	1	EXHAUST FAN, DOGGED		E-8	120	1	1.5			X	5-15P	DVA	B.T.C. ON EXHAUST FAN AS REQUIRED.
21	1	EXHAUST FAN, DOGGED		E-9	120	1	1.5			X	5-15P	DVA	B.T.C. ON EXHAUST FAN AS REQUIRED.
22	1	CONDENSING UNIT		E-10	120	1	1.5			X	5-15P	DVA	B.T.C. ON CONDENSING UNIT AS REQUIRED.
23	1	CONDENSING UNIT		E-11	120	1	1.5			X	5-15P	DVA	B.T.C. ON CONDENSING UNIT AS REQUIRED.
24	1	CONDENSING UNIT		E-12	120	1	1.5			X	5-15P	DVA	B.T.C. ON CONDENSING UNIT AS REQUIRED.
83	1	CONDENSING UNIT		E-71	120	1	1.5			X	5-15P	DVA	B.T.C. ON CONDENSING UNIT AS REQUIRED.
84	1	CONDENSING UNIT		E									

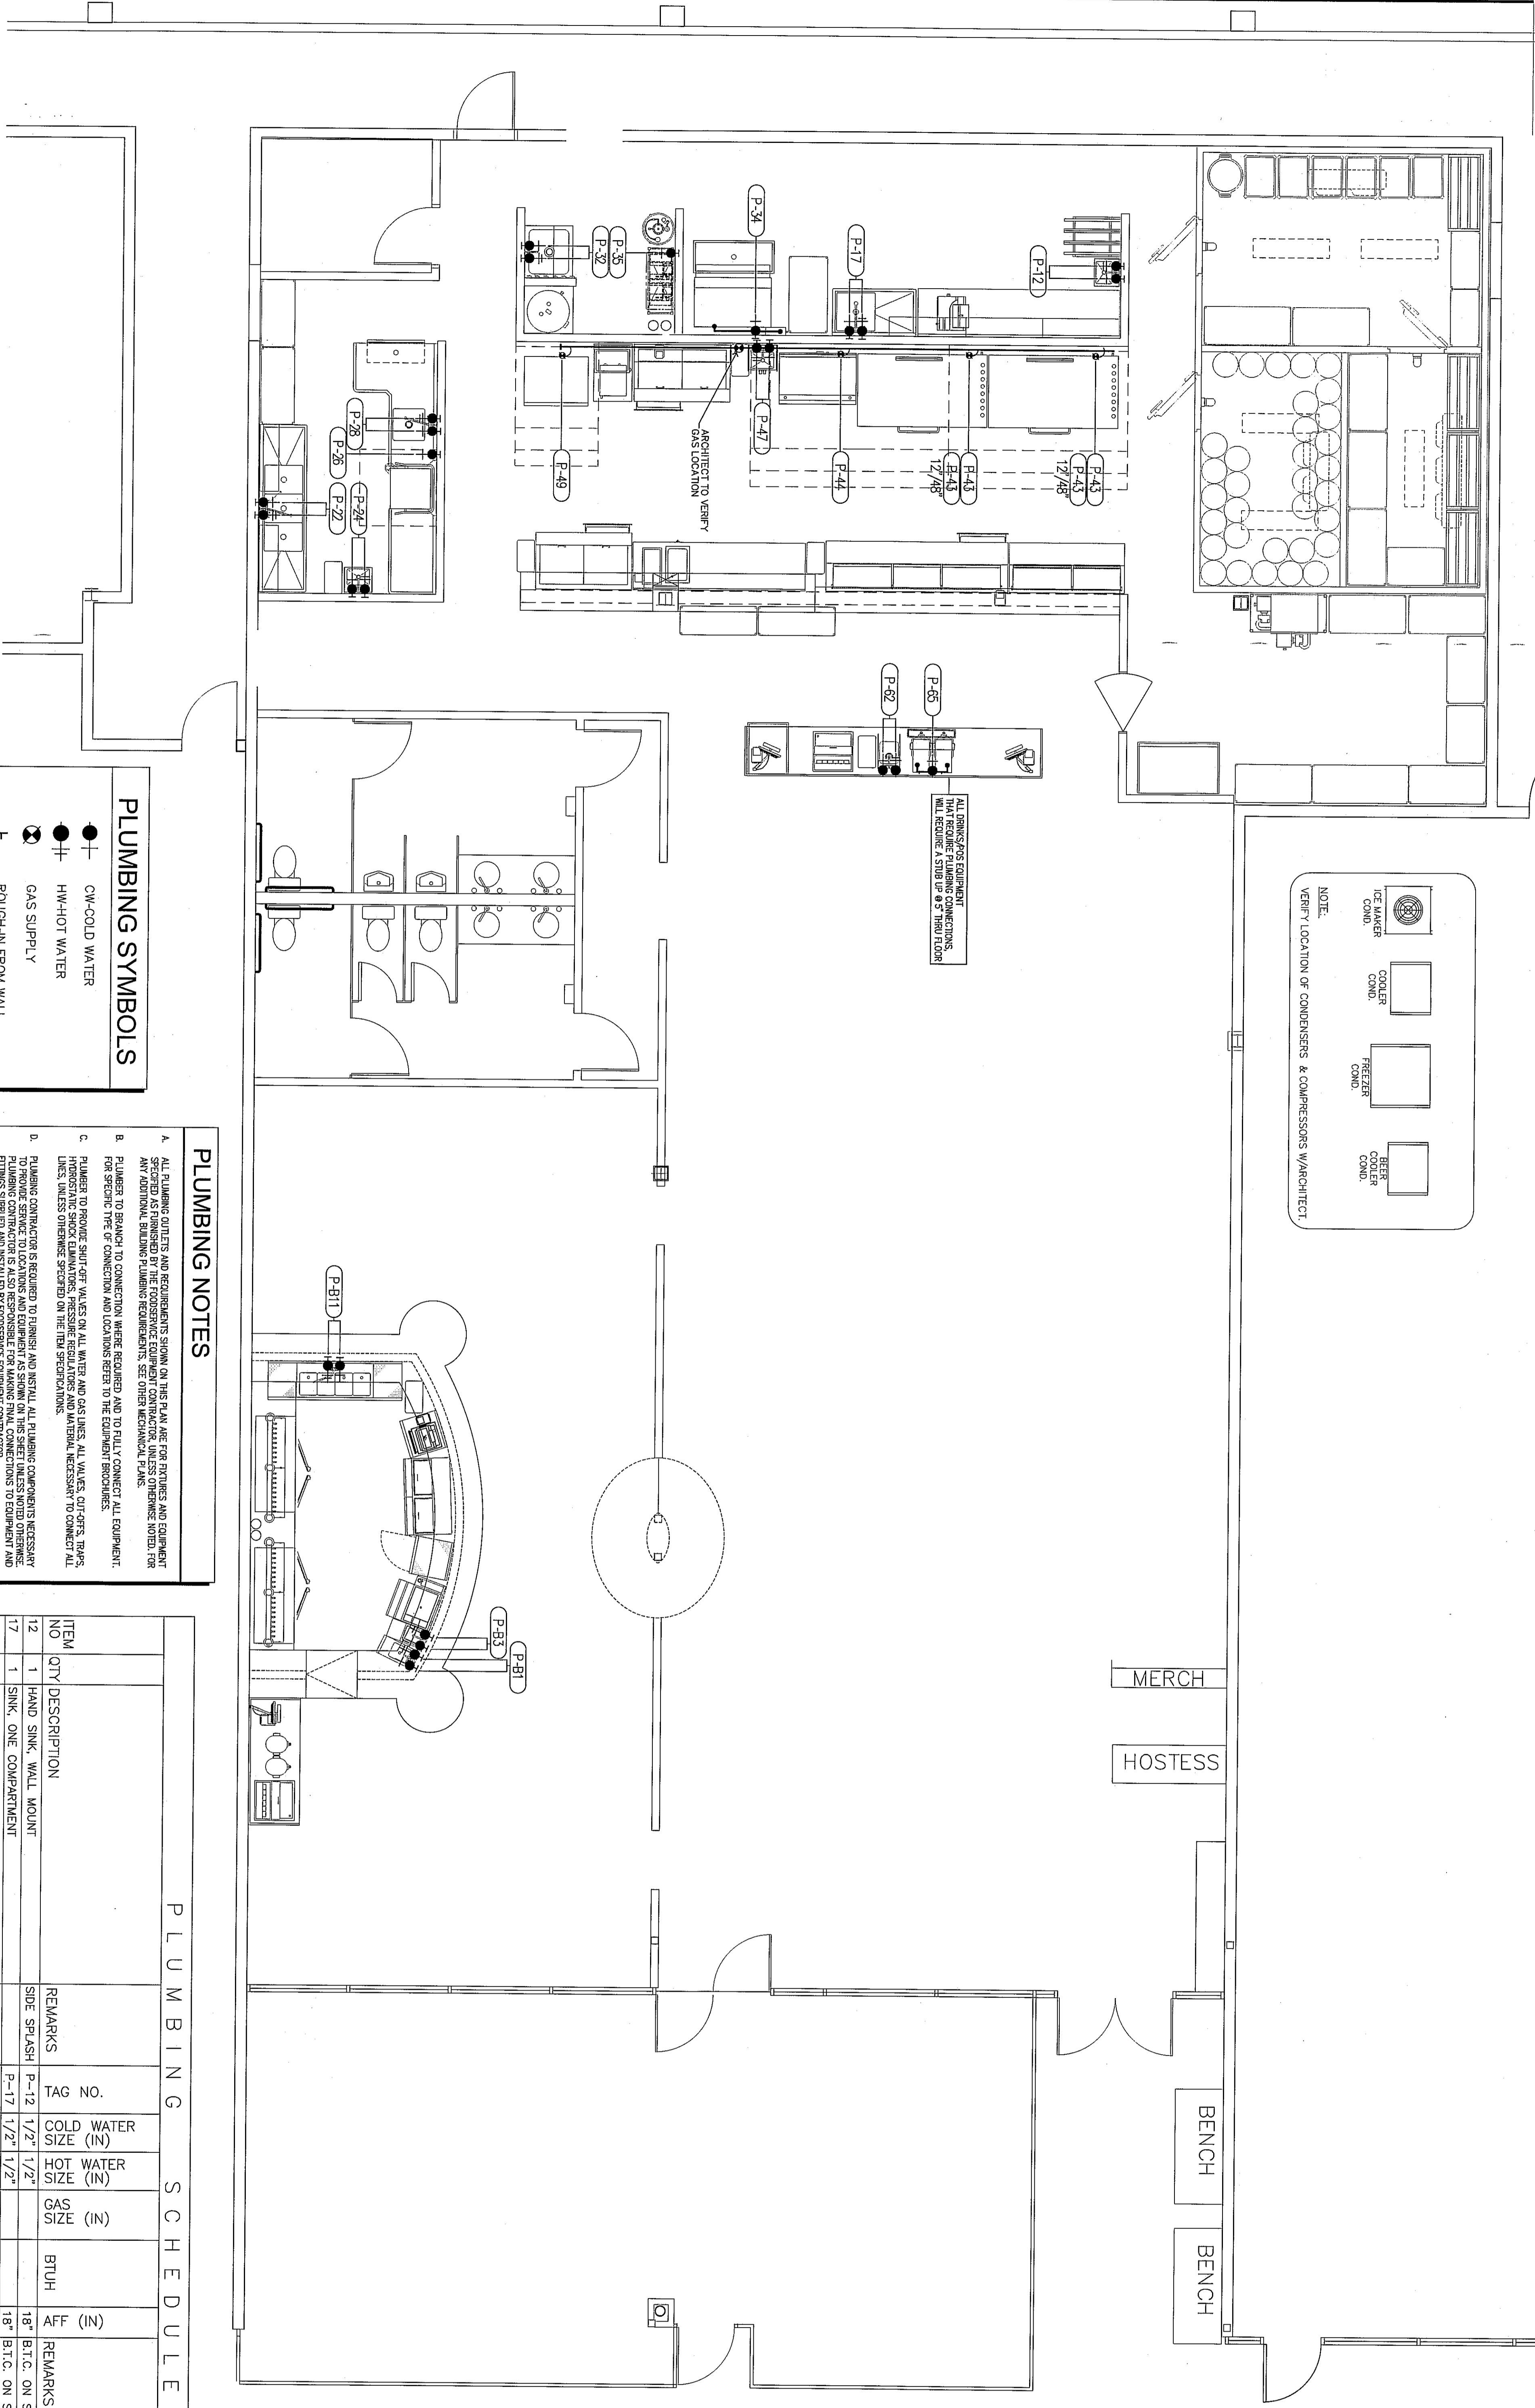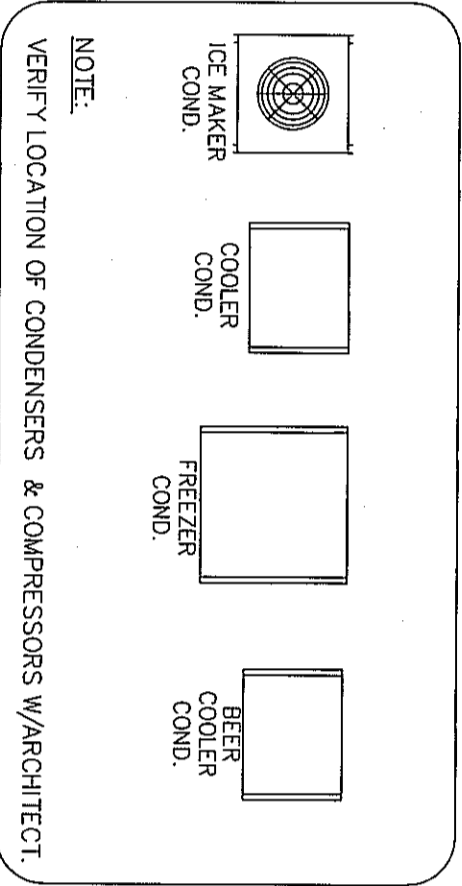


PLUMBING CONNECTIONS FLOOR PLAN
1/4" = 1'-0"

PLUMBING SYMBOLS

- C.W. COLD WATER
- ⊕ H.W. HOT WATER
- ⊙ GAS SUPPLY
- ⊖ ROUGH-IN FROM WALL
- FIELD CONNECTIONS
- B.T.U. BRITISH THERMAL UNIT
- D.F.A. DOWN FROM ABOVE
- A.F.F. ABOVE FINISH FLOOR
- B.I.C. BRANCH TO CONNECTION
- P-# TAG NUMBER

RECOMMENDED WATER FILTER INSTALLATION DIAGRAM

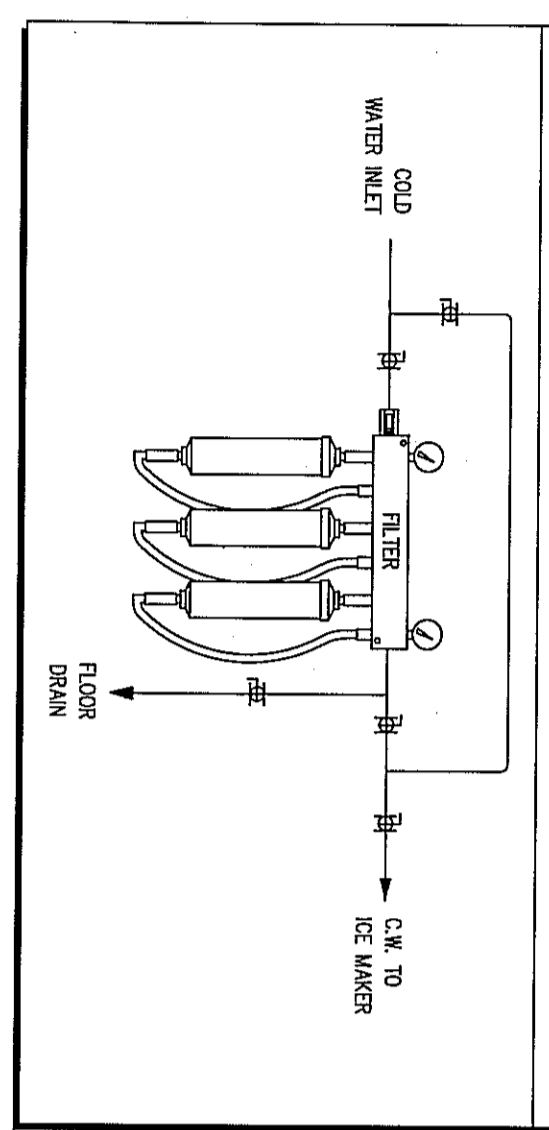

PLUMBING NOTES

- A. ALL PLUMBING CODES AND REQUIREMENTS SHOWN ON THIS PLAN ARE FOR EXERCISE AND EQUIPMENT ONLY. ANY ADDITIONAL BUILDING PLUMBING REQUIREMENTS, SEE OTHER MECHANICAL SCHEDULES FOR ANY ADDITIONAL BUILDING PLUMBING REQUIREMENTS.
- B. PLUMBERS TO VERIFY TO CONNECTIONS WHERE REQUIRED AND TO FULLY CONNECT ALL EQUIPMENT.
- C. FOR SPECIFIC TYPE OF CONNECTION AND LOCATIONS REFER TO THE EQUIPMENT MANUALS.
- D. PLUMBER TO PROVIDE SUFFICIENT WATER AND GAS VALVES, VALVES, CONTROL TRAPS, TRAPS, HYDROSTATIC SHOCK ELIMINATORS, PRESSURE REGULATORS AND AIR VENTS TO COMPLY WITH ALL APPLICABLE CODES AND REGULATIONS.
- E. PLUMBING CONNECTIONS TO BE MADE TO ALL EQUIPMENT. ALL EQUIPMENT SHALL BE INSTALLED AND TESTED BY THE PLUMBER. ALL EQUIPMENT SHALL BE INSTALLED AND TESTED BY THE PLUMBER.
- F. PLUMBING CONNECTIONS TO BE MADE TO ALL EQUIPMENT. ALL EQUIPMENT SHALL BE INSTALLED AND TESTED BY THE PLUMBER.
- G. PLUMBING CONNECTIONS TO BE MADE TO ALL EQUIPMENT. ALL EQUIPMENT SHALL BE INSTALLED AND TESTED BY THE PLUMBER.
- H. PLUMBING CONNECTIONS TO BE MADE TO ALL EQUIPMENT. ALL EQUIPMENT SHALL BE INSTALLED AND TESTED BY THE PLUMBER.
- I. PLUMBING CONNECTIONS TO BE MADE TO ALL EQUIPMENT. ALL EQUIPMENT SHALL BE INSTALLED AND TESTED BY THE PLUMBER.
- J. PLUMBING CONNECTIONS TO BE MADE TO ALL EQUIPMENT. ALL EQUIPMENT SHALL BE INSTALLED AND TESTED BY THE PLUMBER.
- K. PLUMBING CONNECTIONS TO BE MADE TO ALL EQUIPMENT. ALL EQUIPMENT SHALL BE INSTALLED AND TESTED BY THE PLUMBER.
- L. PLUMBING CONNECTIONS TO BE MADE TO ALL EQUIPMENT. ALL EQUIPMENT SHALL BE INSTALLED AND TESTED BY THE PLUMBER.
- M. PLUMBING CONNECTIONS TO BE MADE TO ALL EQUIPMENT. ALL EQUIPMENT SHALL BE INSTALLED AND TESTED BY THE PLUMBER.
- N. PLUMBING CONNECTIONS TO BE MADE TO ALL EQUIPMENT. ALL EQUIPMENT SHALL BE INSTALLED AND TESTED BY THE PLUMBER.
- O. PLUMBING CONNECTIONS TO BE MADE TO ALL EQUIPMENT. ALL EQUIPMENT SHALL BE INSTALLED AND TESTED BY THE PLUMBER.
- P. PLUMBING CONNECTIONS TO BE MADE TO ALL EQUIPMENT. ALL EQUIPMENT SHALL BE INSTALLED AND TESTED BY THE PLUMBER.
- Q. PLUMBING CONNECTIONS TO BE MADE TO ALL EQUIPMENT. ALL EQUIPMENT SHALL BE INSTALLED AND TESTED BY THE PLUMBER.
- R. PLUMBING CONNECTIONS TO BE MADE TO ALL EQUIPMENT. ALL EQUIPMENT SHALL BE INSTALLED AND TESTED BY THE PLUMBER.
- S. PLUMBING CONNECTIONS TO BE MADE TO ALL EQUIPMENT. ALL EQUIPMENT SHALL BE INSTALLED AND TESTED BY THE PLUMBER.
- T. PLUMBING CONNECTIONS TO BE MADE TO ALL EQUIPMENT. ALL EQUIPMENT SHALL BE INSTALLED AND TESTED BY THE PLUMBER.
- U. PLUMBING CONNECTIONS TO BE MADE TO ALL EQUIPMENT. ALL EQUIPMENT SHALL BE INSTALLED AND TESTED BY THE PLUMBER.
- V. PLUMBING CONNECTIONS TO BE MADE TO ALL EQUIPMENT. ALL EQUIPMENT SHALL BE INSTALLED AND TESTED BY THE PLUMBER.
- W. PLUMBING CONNECTIONS TO BE MADE TO ALL EQUIPMENT. ALL EQUIPMENT SHALL BE INSTALLED AND TESTED BY THE PLUMBER.
- X. PLUMBING CONNECTIONS TO BE MADE TO ALL EQUIPMENT. ALL EQUIPMENT SHALL BE INSTALLED AND TESTED BY THE PLUMBER.
- Y. PLUMBING CONNECTIONS TO BE MADE TO ALL EQUIPMENT. ALL EQUIPMENT SHALL BE INSTALLED AND TESTED BY THE PLUMBER.
- Z. PLUMBING CONNECTIONS TO BE MADE TO ALL EQUIPMENT. ALL EQUIPMENT SHALL BE INSTALLED AND TESTED BY THE PLUMBER.

PLUMBING SCHEDULE

ITEM NO.	DESCRIPTION	REMARKS	TAG NO.	COLD WATER (IN)	HOT WATER (IN)	GAS (IN)	BTUH	LF (IN)	REMARKS
12	1 HAND SINK, WALL MOUNT	SIDE SPLASH	P-12	1/2"	1/2"			18"	B.I.C. ON SINK FAUCET AS REQUIRED
17	1 SINK, ONE COMPARTMENT	SIDE SPLASH	P-17	1/2"	1/2"			18"	B.I.C. ON SINK FAUCET AS REQUIRED
22	1 SINK, THREE COMPARTMENT	SIDE SPLASH	P-22	1/2"	1/2"			12"	B.I.C. ON PRE-RINSE UNIT AS REQUIRED
24	1 HAND SINK, WALL MOUNT	SIDE SPLASH	P-24	1/2"	1/2"			18"	B.I.C. ON SINK FAUCET AS REQUIRED
26	1 DISH WASH MACHINE	BY OWNER	P-26		3/4"			18"	B.I.C. ON WATER FILTER, THEN TO MACHINE. VRF. ALL REQ. W/PROVIDER
28	1 DISHABLE, SOLED W/RACK SHELF & P.R. SINK	BY OWNER	P-28	1/2"	1/2"			18"	B.I.C. ON PRE-RINSE UNIT AS REQUIRED. VRF. ALL REQ. W/PROVIDER
32	1 MOP SINK W/ UTILITY FAUCET	BY OWNER	P-32	1/2"	1/2"			36"	B.I.C. ON SINK FAUCET AS REQUIRED. VRF. ALL REQ. W/PROVIDER
34	1 ICE MACHINE W/BIN & WATER FILTER	BY OWNER	P-34	1/2"	1/2"			78"	B.I.C. ON WATER FILTER, THEN TO ICE MACHINE
35	2 BAG-IN-BOX	BY OWNER	P-35	1/2"	1/2"			84"	B.I.C. ON WATER FILTER, THEN TO ICE MACHINE
43	2 PIZZA OVEN, DOUBLE DECK, GAS	MOBILE	P-43			2(13/4")	320,000	12"	B.I.C. ON SINK FAUCET AS REQUIRED
44	1 48" GRIDDLE, GAS	MOBILE	P-44			3/4"	120,000	12"	B.I.C. ON SINK FAUCET AS REQUIRED
47	1 HAND SINK, PEDESTAL BASE, FOOT VALVE	MOBILE	P-47	1/2"	1/2"			18"	B.I.C. ON SINK FAUCET AS REQUIRED
49	1 CONNECTION, OPEN, GAS	MOBILE	P-49			3/4"	50,000	12"	B.I.C. ON SINK FAUCET AS REQUIRED
81	2 ICE TEA BREWER	BY OWNER	P-81	1/2"	1/2"			5"	STUB UP AND B.I.C. ON SINK FAUCET AS REQUIRED
83	1 UNDERBAR HAND SINK	BY OWNER	P-83	1/2"	1/2"			12"	B.I.C. ON SINK FAUCET AS REQUIRED
83	1 UNDERBAR BLENDER STATION	BY OWNER	P-83	1/2"	1/2"			12"	B.I.C. ON SINK FAUCET AS REQUIRED
811	1 UNDERBAR FOUR COMPARTMENT SINK	BY OWNER	P-811	1/2"	1/2"			12"	B.I.C. ON SINK FAUCET AS REQUIRED

Strategic
EQUIPMENT AND SUPPLY CORPORATION
3011 Industrial Parkway East
Knoxville, Tennessee 37921
(Pleasant Ridge Industrial Park)
Phone (865) 637-2525
Fax (865) 522-4448

SEAL



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NO.	DATE	DESCRIPTION
C3	11-28-2011	CONCEPTUAL DESIGN
C4	02-01-2012	HIGH CHANGES
C5	02-02-2012	HIGH CHANGES
1	02-24-2012	MEP DRAWINGS

Mellow Mushroom Pizza Bakers
16000 Steubner Airline Road
Spring, TX 77379
PLUMBING CONNECTIONS FLOOR PLAN

SCALE: 1/4" = 1'-0"
DRAWN BY: JMI
CHECKED BY: BR
DATE DRAWN: 01-12-2012
DATE ISSUED: -
PROJECT NO.: 1202-F-06

FS-3
SHEET NUMBER

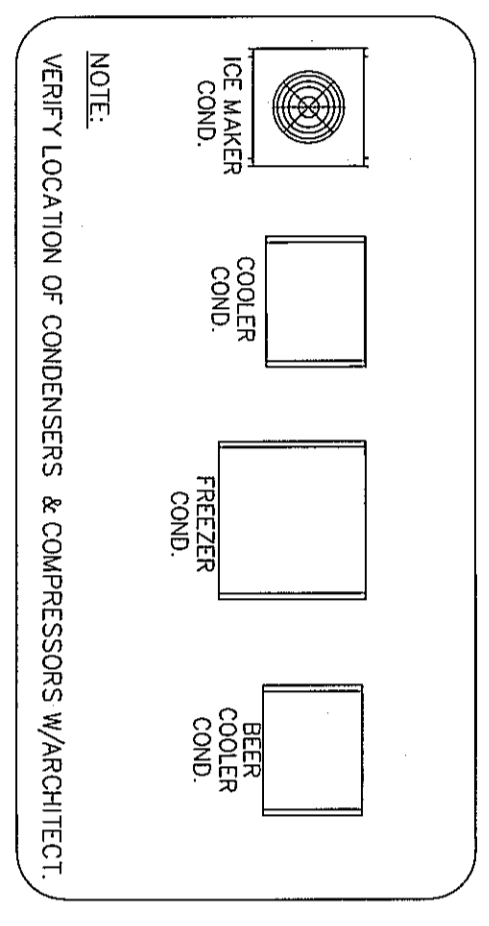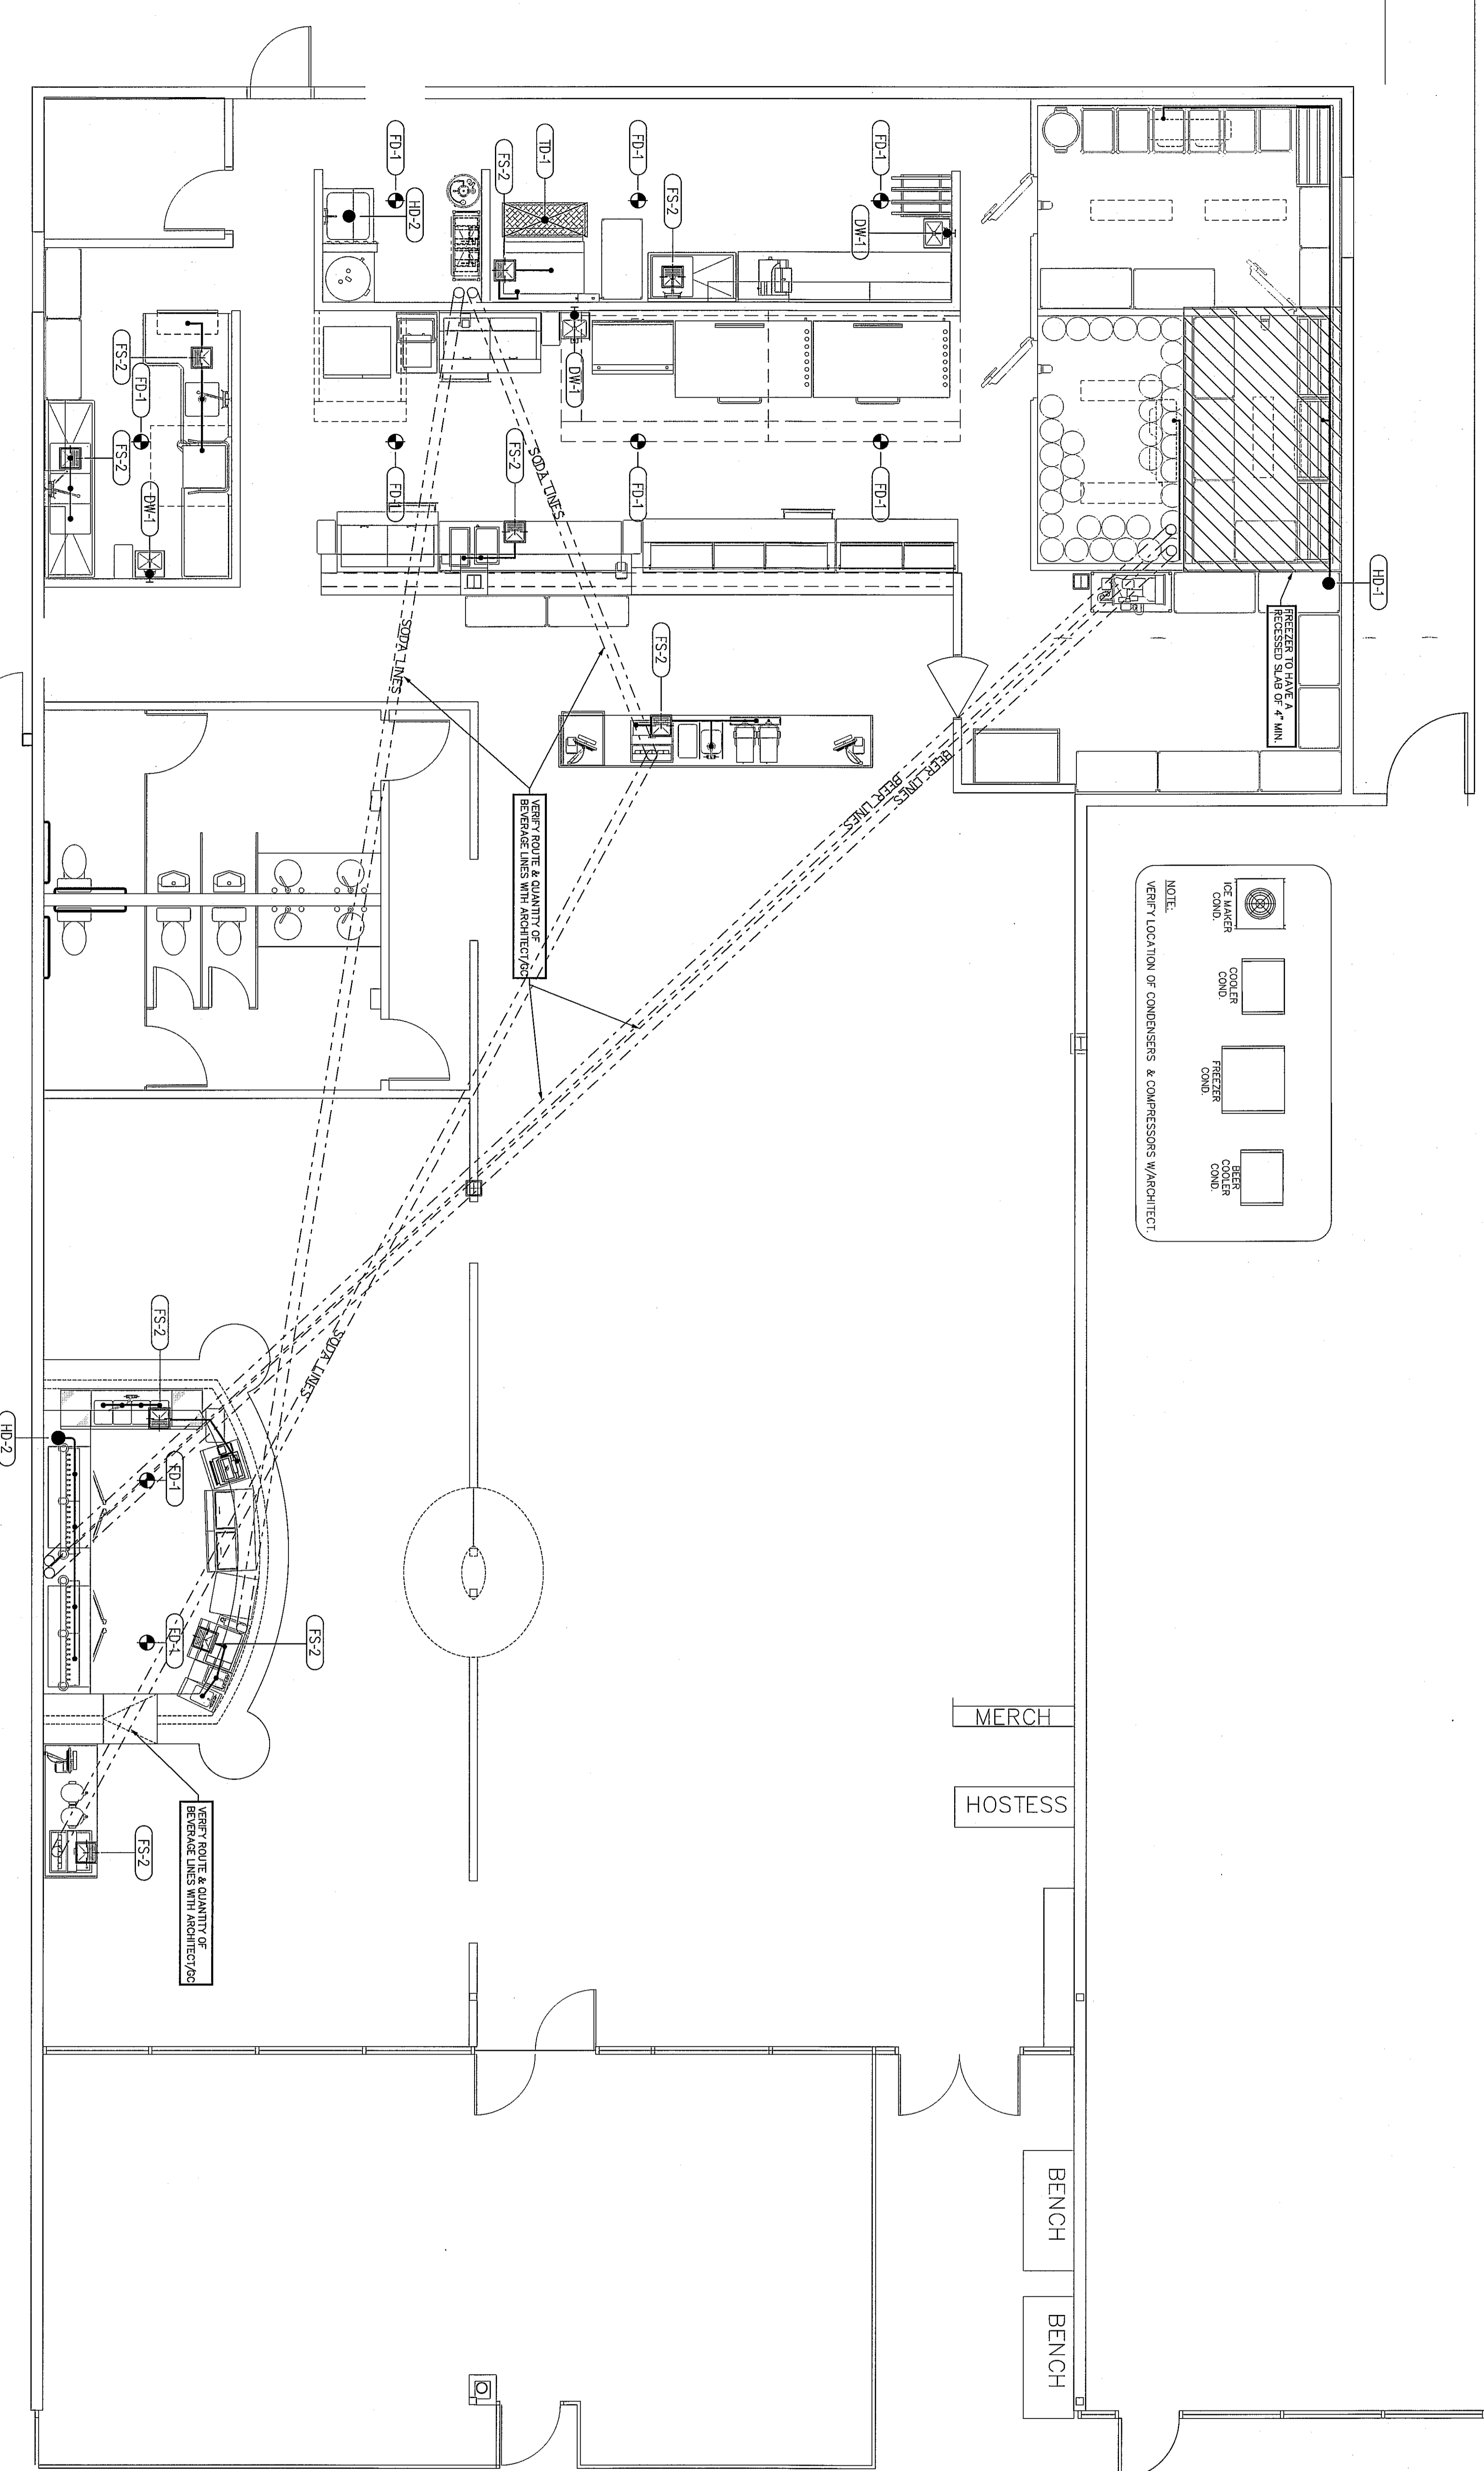



WASTE SYMBOLS

- FS-3 = FLOOR SINK LESS GRATE 10" DEEP
- FS-2 = FLOOR SINK W/ WASTE GRATE
- FS-1 = FLOOR SINK WITH 8" X 8" TOP GRATE
- FD-1 = FLOOR DRAIN WITH TYPE "A" STRAINER 5" TOP AT 12" AFF. FOR HANDWASH SINK AND WATER COOLER
- DM-1 = 1-1/2" DIRECT WASTE LINE - ROUGHED IN WALL AT 12" AFF. FOR DISPENSER
- DM-2 = 2" DIRECT WASTE LINE - ROUGHED IN WALL AT 12" AFF. FOR DISPENSER
- DM-3 = 3" DIRECT WASTE LINE - ROUGHED IN WALL AT 12" AFF. FOR DISPENSER
- HD-1 = 1" INDIRECT WASTE LINE - FOR EVAPORATOR COIL DRAIN LINES
- HD-2 = 2" INDIRECT WASTE LINE - ROUGHED IN FINISHED FLOOR AT 3" AFF. FOR MOP SINK - (VERIFY REQUIREMENTS) BOTTOM OUTLET, PROVIDE FLOOR RECESS TO ACCOMMODATE FLOOR CONNECTIONS
- HD-3 = 3" INDIRECT WASTE LINE - ROUGHED IN FINISHED FLOOR AT 3" AFF. FOR MOP SINK - (VERIFY REQUIREMENTS) BOTTOM OUTLET, PROVIDE FLOOR RECESS TO ACCOMMODATE FLOOR CONNECTIONS
- HD-4 = 4" INDIRECT WASTE LINE - ROUGHED IN FINISHED FLOOR AT 3" AFF. FOR MOP SINK - (VERIFY REQUIREMENTS) BOTTOM OUTLET, PROVIDE FLOOR RECESS TO ACCOMMODATE FLOOR CONNECTIONS
- XXX TAG NUMBER

WASTE NOTES

- A. ALL FINISHING CONTRACTORS AND REQUIREMENTS SHOWN ON THIS PLAN ARE FOR FIXTURES AND EQUIPMENT ONLY. THE FINISHING CONTRACTOR SHALL BE RESPONSIBLE FOR THE PROPER INSTALLATION OF ALL FINISHING ITEMS AND SHALL VERIFY THE LOCATION AND QUANTITY OF ALL ITEMS WITH THE ARCHITECT/MEP PRIOR TO INSTALLATION.
- B. PLUMBER TO VERIFY ALL DRAIN LINES, AND WASTE LINES, ETC. CONNECT TO THE CORRECT WASTE FROM THE EQUIPMENT TO THE MAIN DRAIN. VERIFY THE LOCATION AND QUANTITY OF ALL ITEMS WITH THE ARCHITECT/MEP PRIOR TO INSTALLATION.
- C. ALL WASTE LINES SHALL BE INSTALLED WITH A MINIMUM SLOPE OF 1/4" PER FOOT. VERIFY THE LOCATION AND QUANTITY OF ALL ITEMS WITH THE ARCHITECT/MEP PRIOR TO INSTALLATION.
- D. ALL WASTE LINES SHALL BE INSTALLED WITH A MINIMUM SLOPE OF 1/4" PER FOOT. VERIFY THE LOCATION AND QUANTITY OF ALL ITEMS WITH THE ARCHITECT/MEP PRIOR TO INSTALLATION.
- E. PLUMBING CONTRACTOR IS REQUIRED TO VERIFY ALL PLUMBING CONNECTIONS NECESSARY TO THE EQUIPMENT. VERIFY THE LOCATION AND QUANTITY OF ALL ITEMS WITH THE ARCHITECT/MEP PRIOR TO INSTALLATION.
- F. CONTRACTOR TO PROVIDE RECESS IN COMPLIANCE WITH THE N.Y.C. BUILDING CODE.
- G. MOP SINKS OR BENCHES IN SCHEDULE DO NOT REQUIRE PLUMBING CONTRACTOR FROM COMPLETE AND FINISHING CONTRACTOR TO VERIFY THE LOCATION AND QUANTITY OF ALL ITEMS WITH THE ARCHITECT/MEP PRIOR TO INSTALLATION.
- H. ALL WORK SHALL BE IN ACCORDANCE WITH THE N.Y.C. BUILDING CODE AND ALL OTHER APPLICABLE REGULATIONS AND ORDINANCES.

INSLAB SYMBOLS

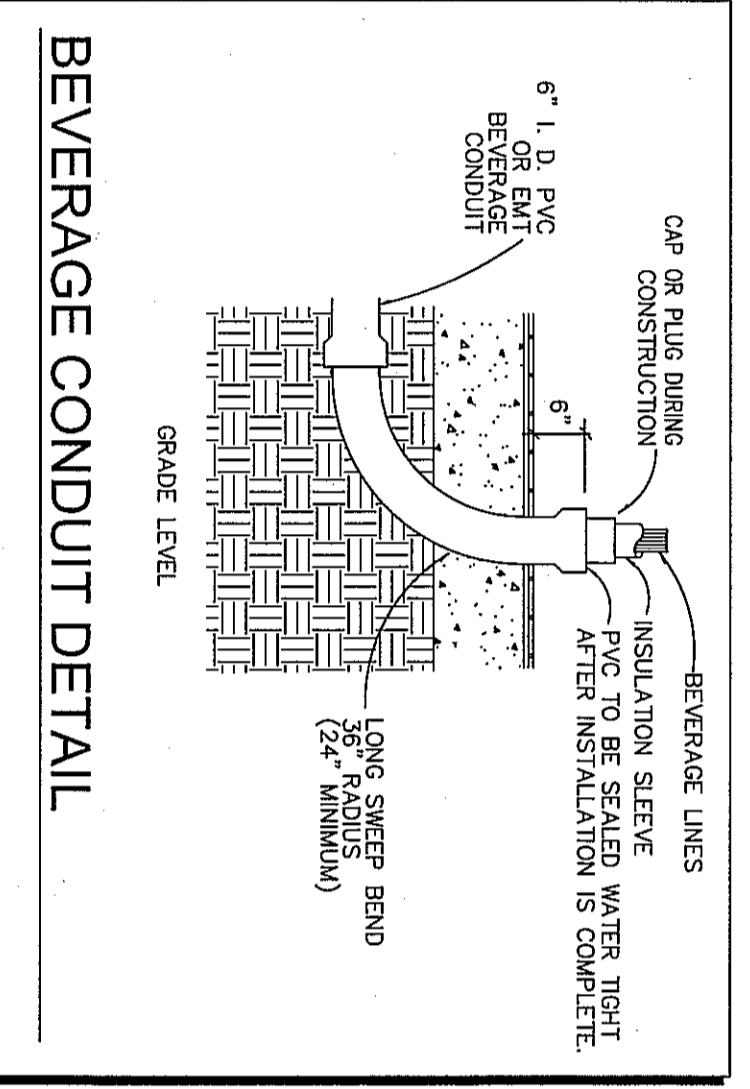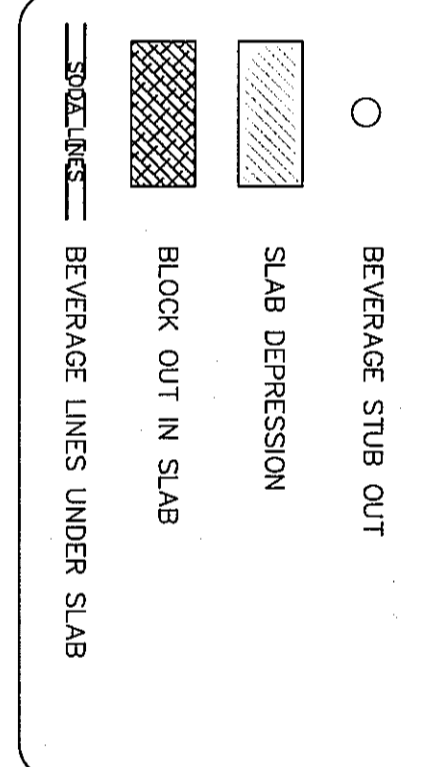

NOTE
GENERAL CONTRACTOR TO PROVIDE EMPTY 6" DIA. P.V.C. FOR RUN OF BEVERAGE LINES TO BE INSTALLED BY PLUMBING CONTRACTOR. GENERAL CONTRACTOR TO VERIFY THE LOCATION AND QUANTITY OF ALL ITEMS WITH THE ARCHITECT/MEP PRIOR TO INSTALLATION.

WASTE SCHEDULE

ITEM NO.	QTY	DESCRIPTION	REMARKS	TAG NO.	DIRECT DRAIN SIZE (IN)	INDIRECT DRAIN SIZE (IN)	AFF (IN)	REMARKS
1	1	WALK-IN COOLER EVAPORATOR COIL		HD-1	5/8"	5/8"	FUR	CONNECT DRAIN LINE. EXTEND TO HUB DRAIN
2	1	WALK-IN FREEZER EVAPORATOR COIL		HD-1	5/8"	5/8"	FUR	CONNECT DRAIN LINE. EXTEND TO HUB DRAIN
3	1	WALK-IN BEER COOLER EVAPORATOR COIL		HD-1	5/8"	5/8"	FUR	CONNECT DRAIN LINE. EXTEND TO HUB DRAIN
4	1	HAND SINK, WALL MOUNT		DM-1	1 1/2"	2"	FUR	CONNECT DRAIN LINE AS REQUIRED
5	1	SINK, THREE COMPARTMENT		FS-2	2"	2"	FUR	CONNECT DRAIN LINE. EXTEND TO FLOOR SINK
6	1	SINK, WALL MOUNT		DM-1	1 1/2"	2"	FUR	CONNECT DRAIN LINE AS REQUIRED
7	1	DISHTHROUGH, SOLED W/FRACK SHELF & P.R. SINK		FS-2	1 1/2"	2"	FUR	CONNECT DRAIN LINE AS REQUIRED
8	1	MOP SINK		HD-2	3"	3"	VAF	VERIFY REQUIREMENTS AND LOCATION W/ OWNER
9	1	FLOOR THROUGH		FS-2	3/4"	3/4"	FUR	CONNECT DRAIN LINE. EXTEND TO FLOOR SINK
10	1	ICE MACHINE W/ BIN & WATER FILTER		HD-2	3/4"	3/4"	VAF	VERIFY REQUIREMENTS AND LOCATION W/ OWNER
11	1	HAND SINK, PEDIESTAL BASE, FOOT VALVE		DM-1	1 1/2"	2"	FUR	CONNECT DRAIN LINE AS REQUIRED
12	1	WARBER, FOOD - (12X20), DROP-IN		FS-2	2"	2"	FUR	CONNECT DRAIN LINE AS REQUIRED
13	1	COLD WELL, (ICE-COOLED)		FS-2	2"	2"	FUR	CONNECT DRAIN LINE AS REQUIRED
14	2	SODA DISPENSER W/ICE CHEST (DMP-IN)		DM-1	1 1/2"	2"	FUR	CONNECT DRAIN LINE. EXTEND TO FLOOR SINK
15	1	UNDERBAR HAND SINK		FS-2	1 1/2"	1 1/2"	FUR	CONNECT DRAIN LINE. EXTEND TO FLOOR SINK
16	1	UNDERBAR COCKTAIL STATION W/COLD PLATE		FS-2	1 1/2"	1 1/2"	FUR	CONNECT DRAIN LINE. EXTEND TO FLOOR SINK
17	1	UNDERBAR BLENDER STATION		FS-2	1 1/2"	1 1/2"	FUR	CONNECT DRAIN LINE. EXTEND TO FLOOR SINK
18	1	BEER TAPS (24) & DRAIN PAN		HD-2	1"	1"	FUR	CONNECT DRAIN LINE. EXTEND TO FLOOR SINK
19	1	UNDERBAR BEER BOARD W/GLASS RACK		FS-2	1"	1"	FUR	CONNECT DRAIN LINE. EXTEND TO FLOOR SINK
20	1	UNDERBAR FOUR COMPARTMENT SINK		FS-2	1"	1"	FUR	CONNECT DRAIN LINE. EXTEND TO FLOOR SINK





3011 Industrial Parkway East
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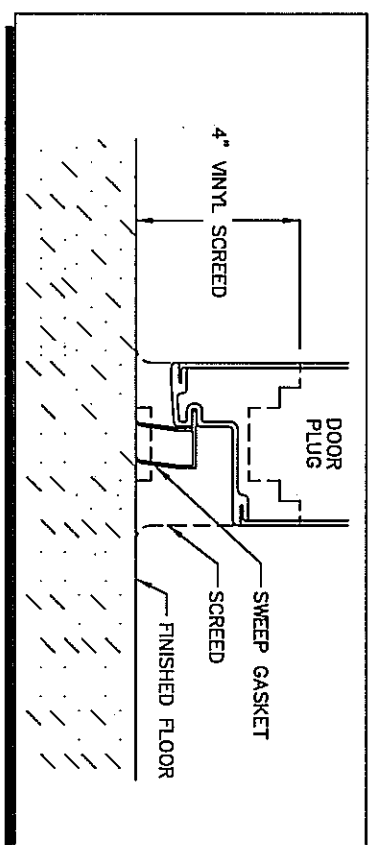
NO.	DATE	DESCRIPTION
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C4	12-01-2012	HIGH CHANGES
C5	12-24-2012	HIGH CHANGES
1	12-24-2012	MEP DRAWINGS

Mellow Mushroom Pizza Bakers
16000 Steubner Airline Road
Spring, TX
INSLAB & WASTE CONNECTIONS FLOOR PLAN


SCALE: 1/4" = 1'-0"
DRAWN BY: JM
CHECKED BY: BR
DATE DESIGNED: 01-12-2012
DATE ESTIMATED: 12-20-12
PROJECT NO: 1202F-06
FS-4
SHEET NUMBER




SPECIAL CONDITIONS FLOOR PLAN
1/4" = 1'-0"

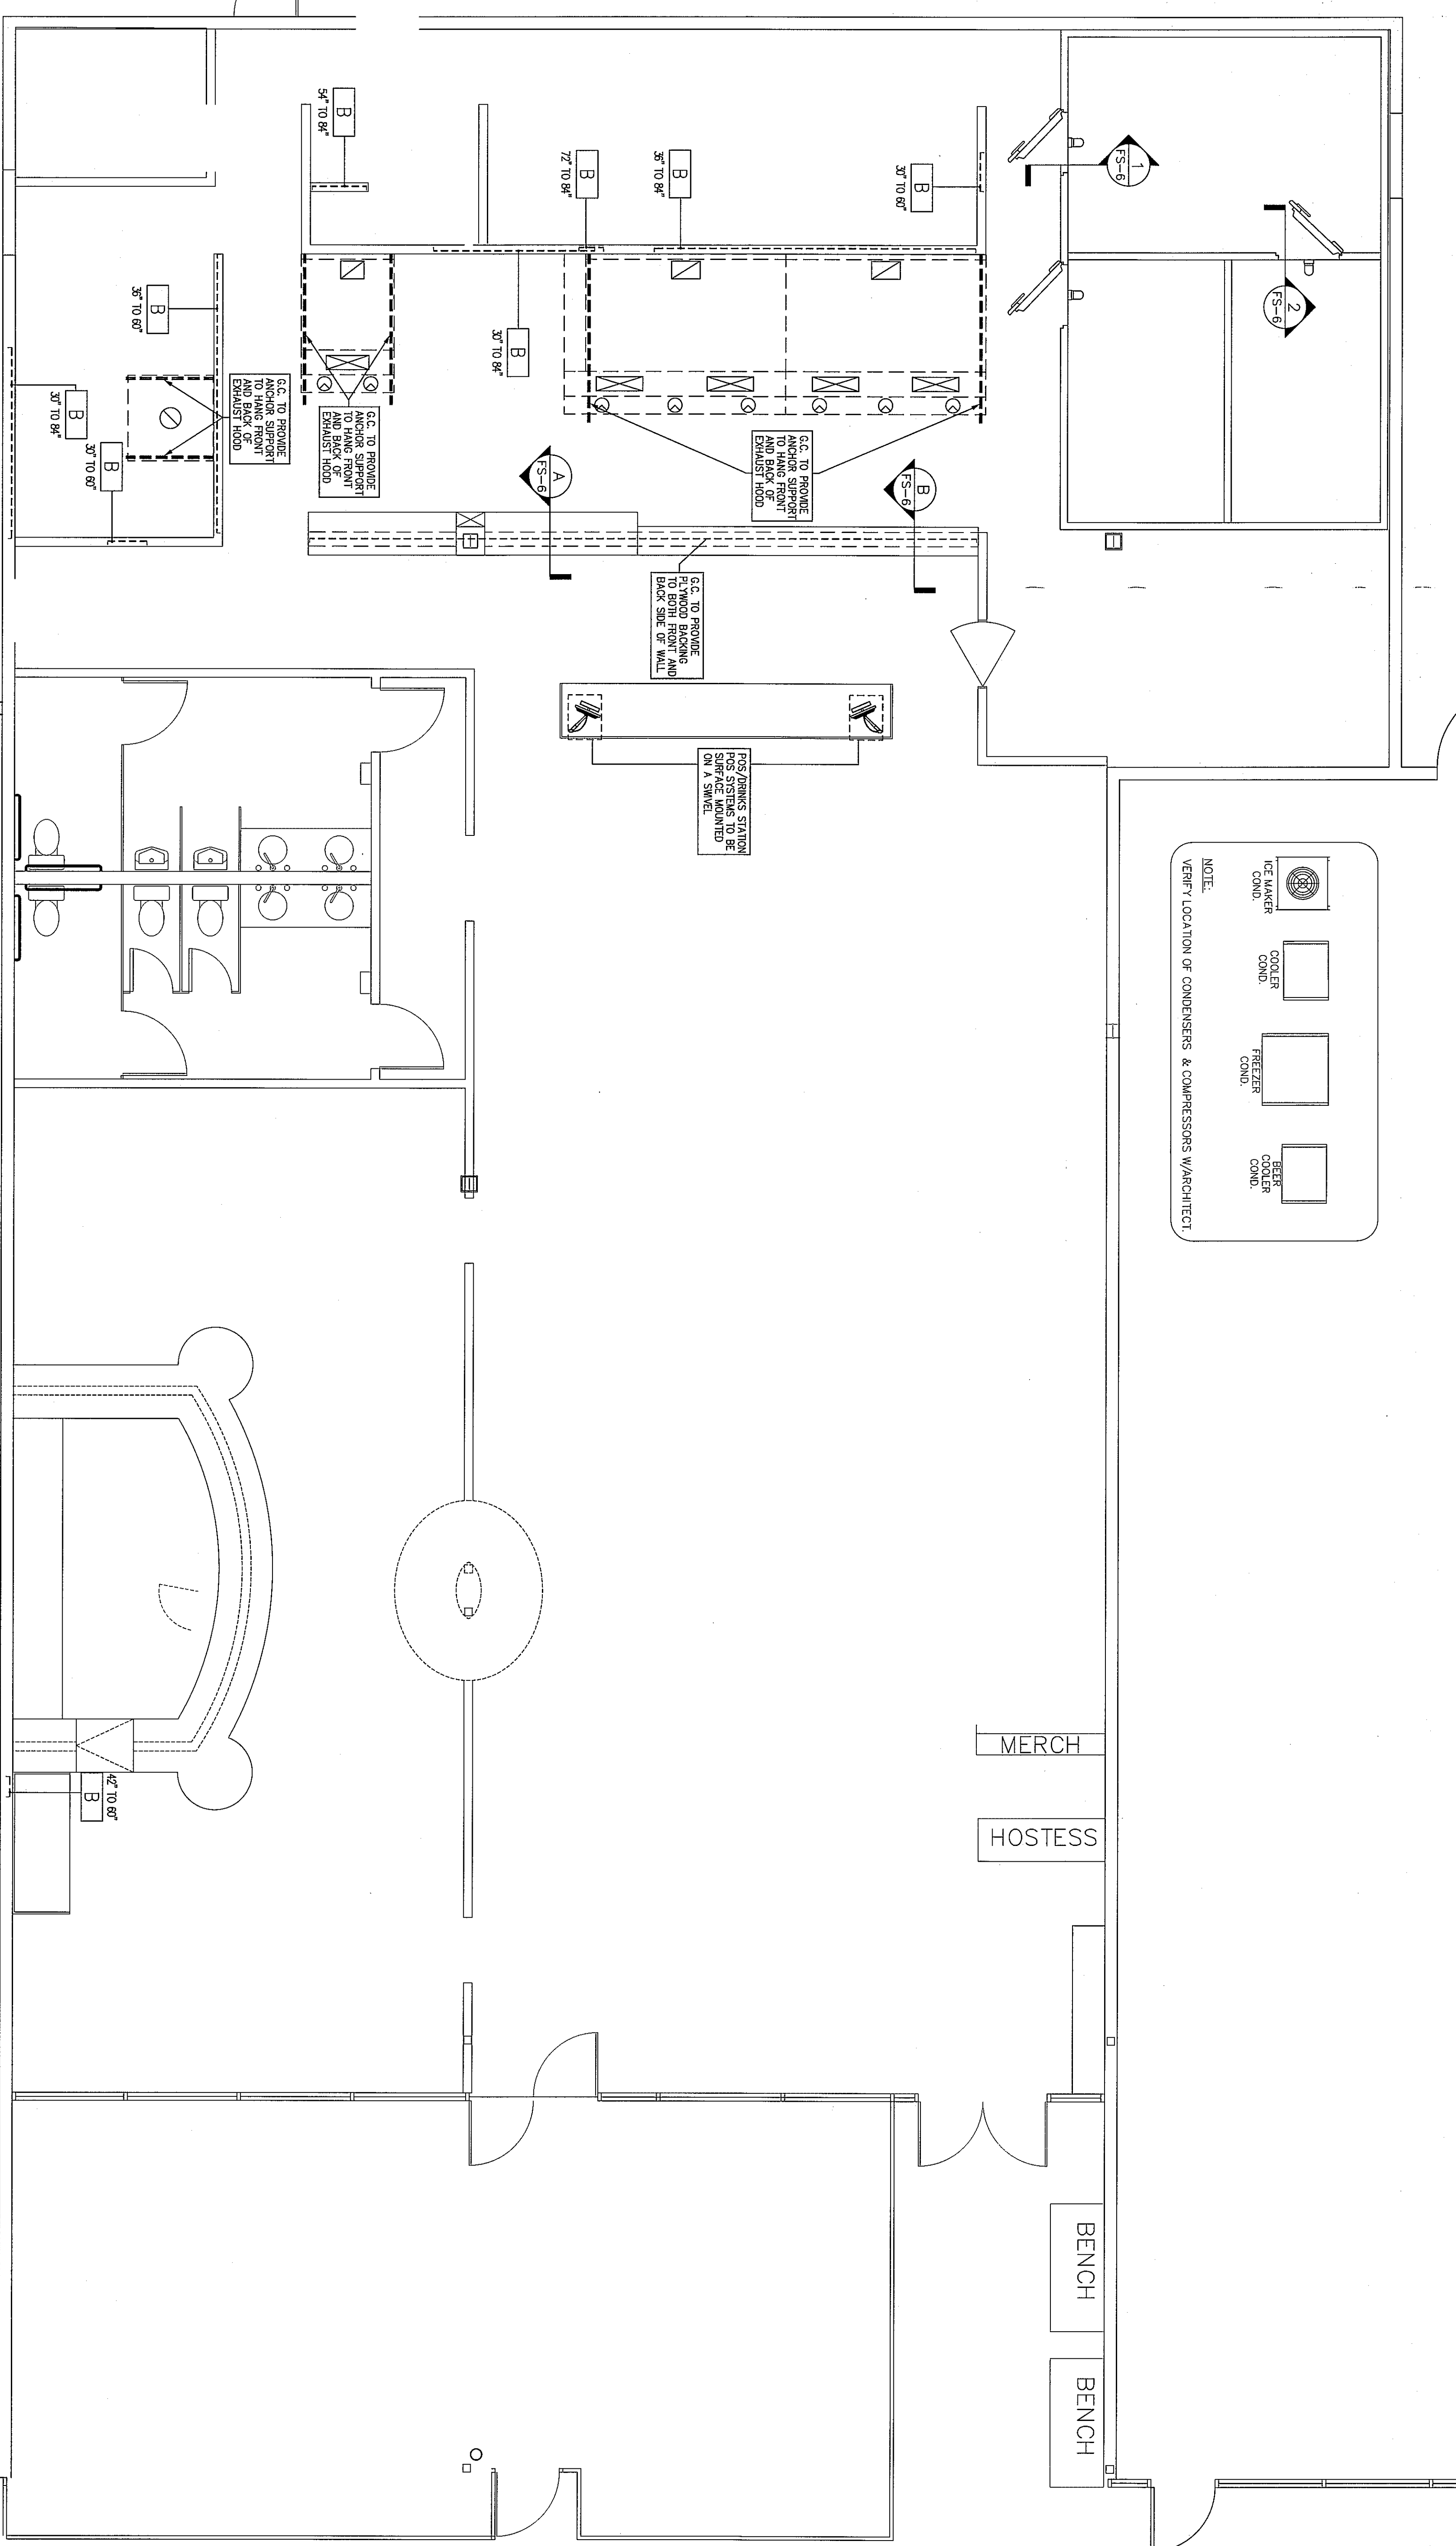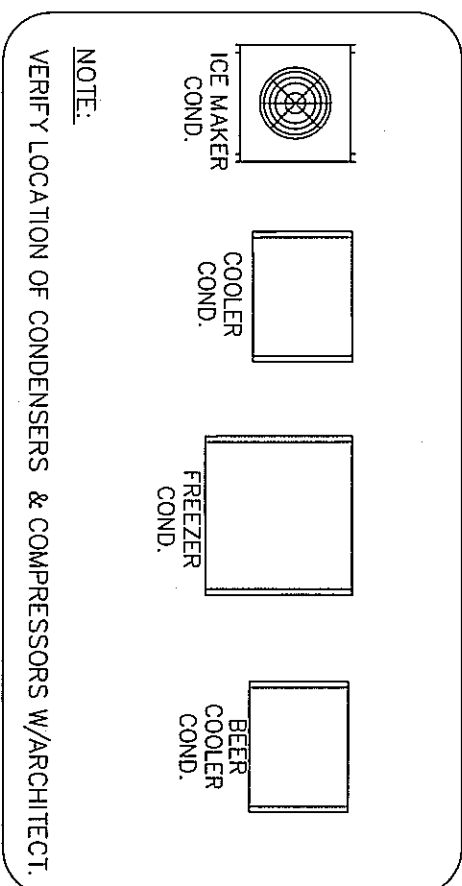


1 **DETAIL OF WALK-IN COOLER FLOOR**
NO SCALE

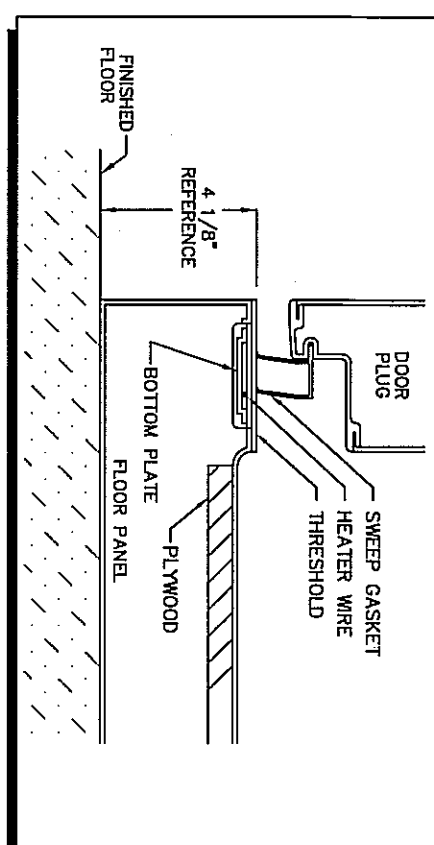


2 **DETAIL OF WALK-IN FREEZER FLOOR**
NO SCALE

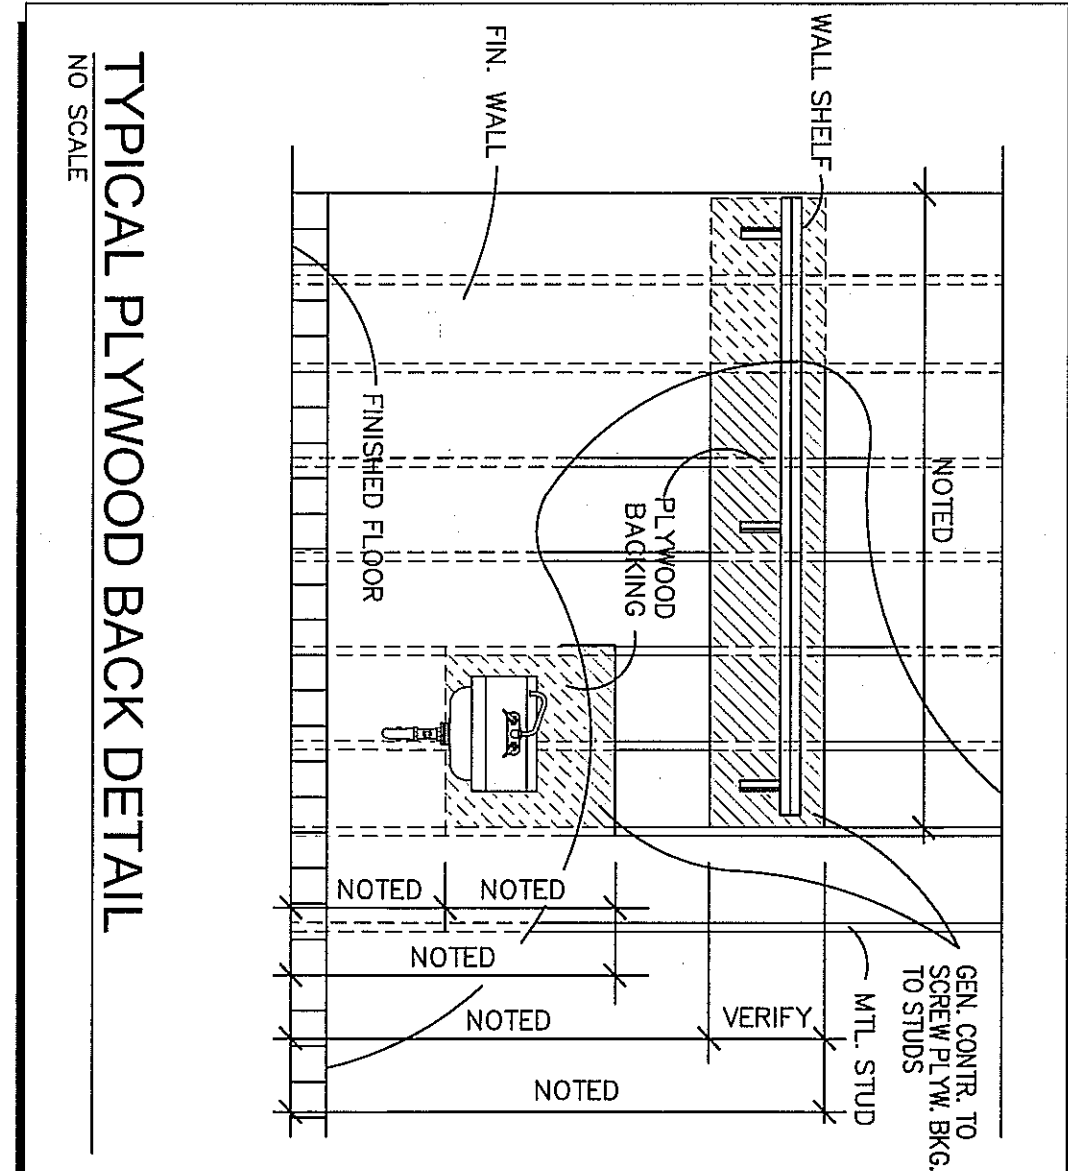

TYPICAL PLYWOOD BACK DETAIL
NO SCALE

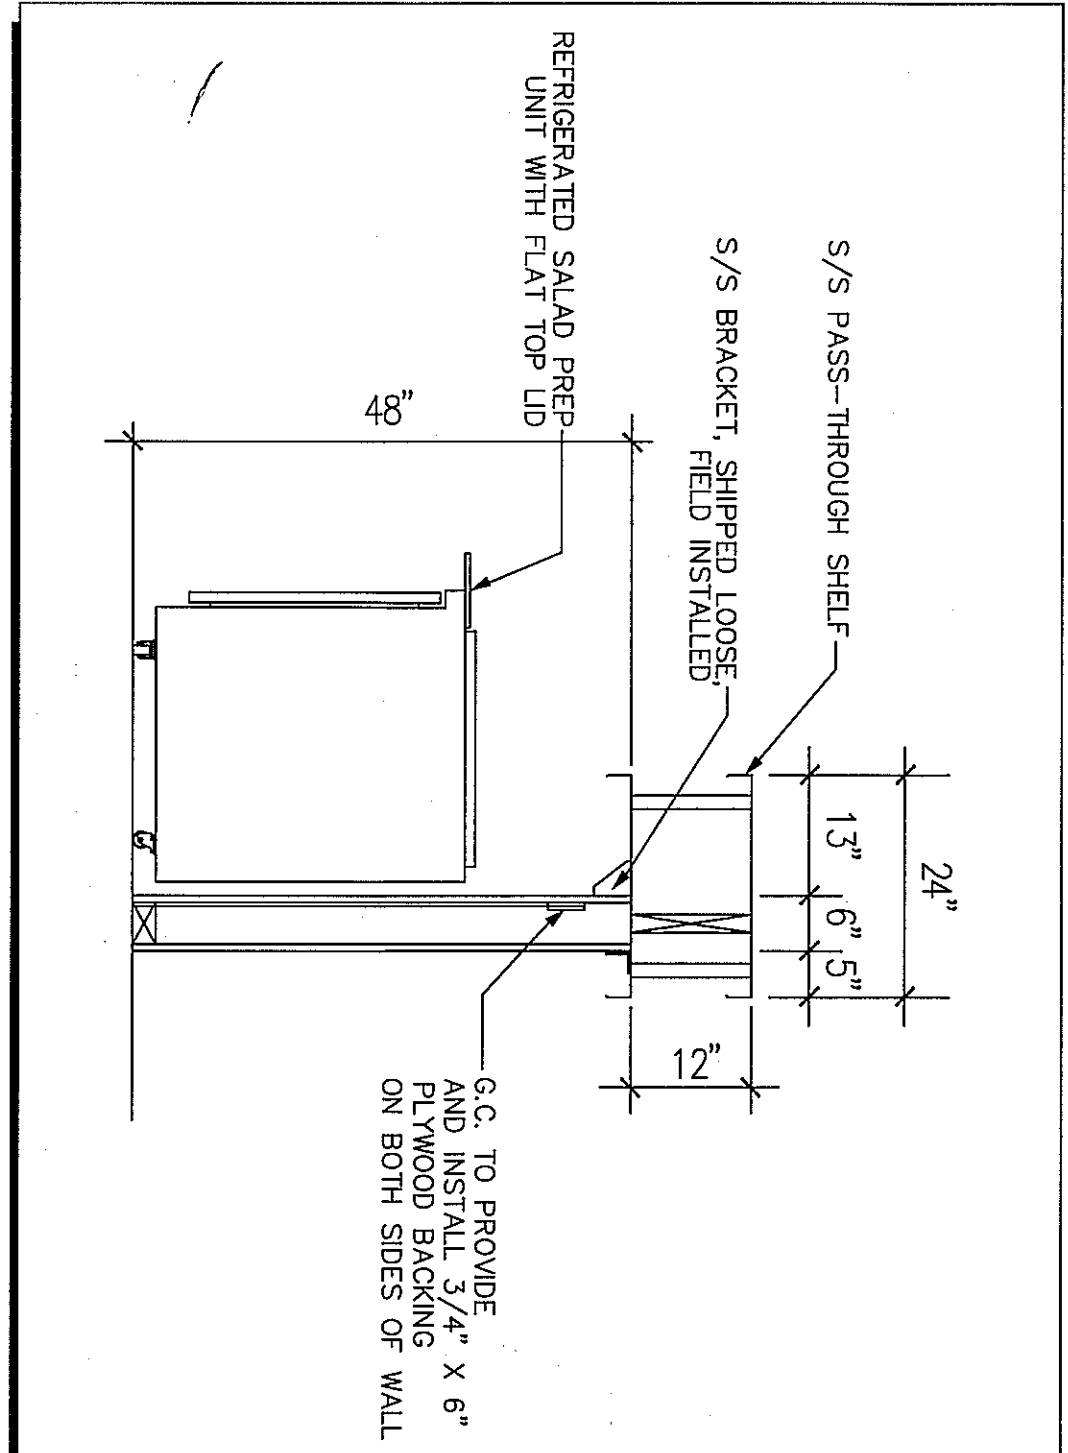

A **PASS-THRU DETAIL @ SALAD PREP UNIT**
NO SCALE

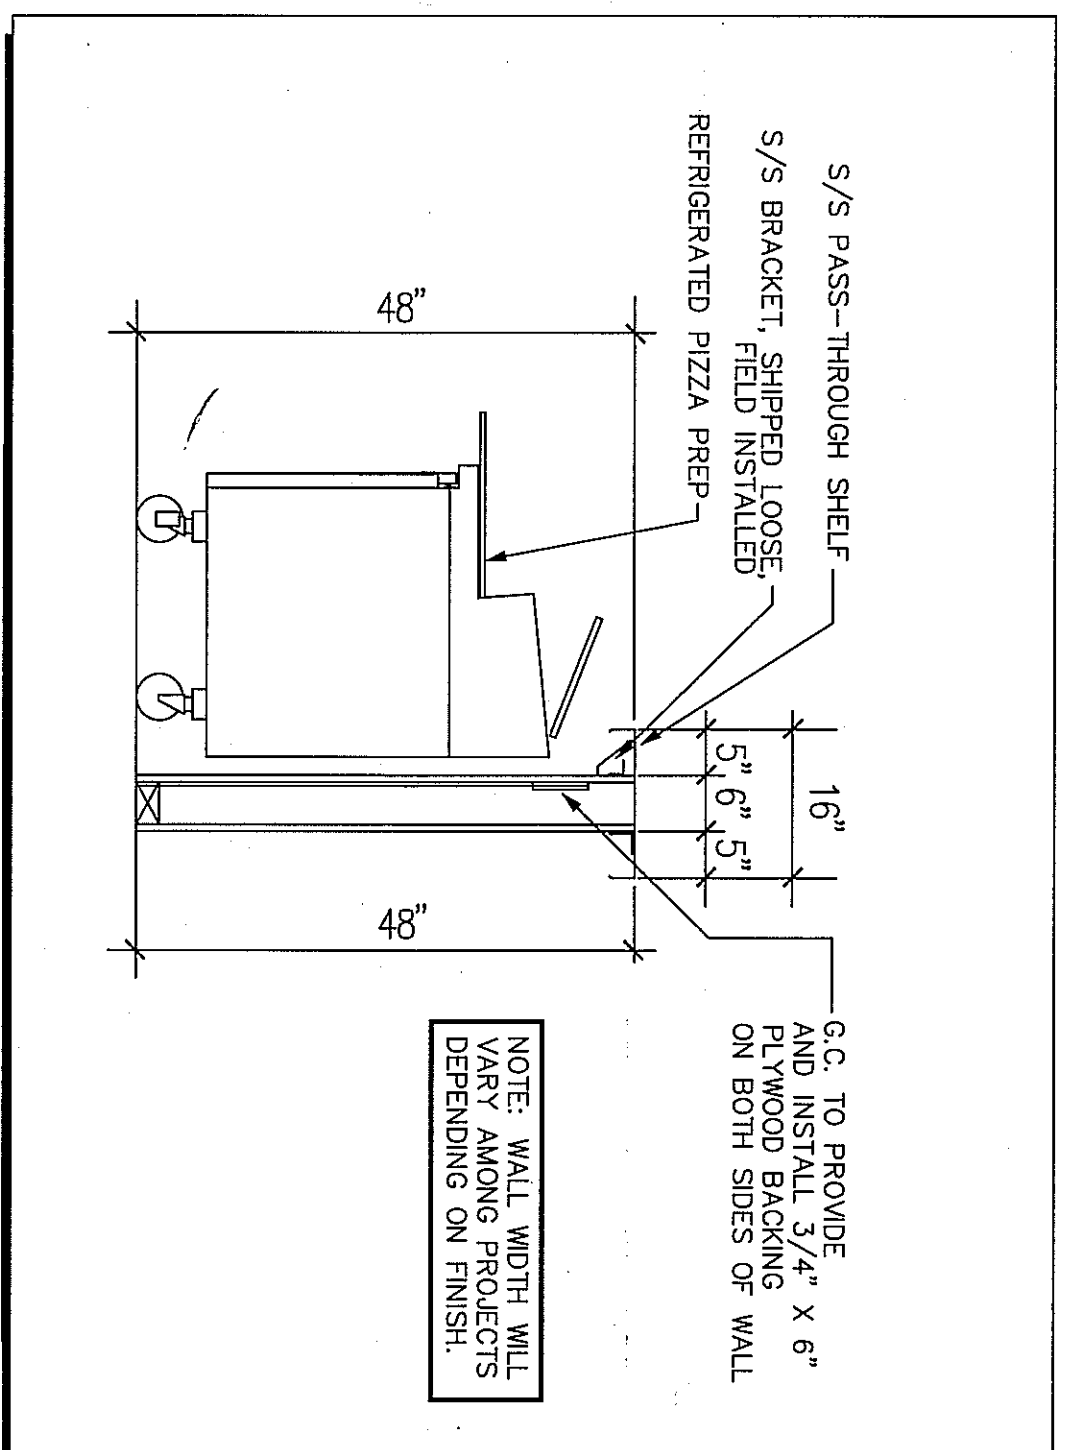

B **PASS-THRU DETAIL @ PIZZA PREP UNIT**
NO SCALE

NOTE:
ALL ROOF PENETRATIONS ARE BY THE CONTRACTOR. VERIFY EXACT LOCATION OF WALK-IN CONDENSERS WITH S&P CONTRACTOR.

SPECIAL BUILDING CONDITIONS
BACKING REQUIRED IN WALL FOR WALK-IN MOUNTED EQUIPMENT. BACKING OTHERWISE NOTED, AND SHALL EXTEND BETWEEN DIMENSIONS SHOWN AT REMOVE CALLOUT.

SEAL

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REVISIONS	
NO.	DATE
03	01-26-2012
04	02-01-2012
05	02-02-2012
1	02-24-2012

Mellow Mushroom Pizza Bakers
16000 Steubner Airline Road
Spring, TX 77379
SPECIAL CONDITIONS FLOOR PLAN

SCALE	1/4" = 1'-0"
DESIGNER	JM
CHECKED BY	BR
DATE DRAWN	01-12-2012
DATE ISSUED	
PROJECT NO.	1202-F-06

FS-5
SHEET NUMBER

Strategic
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